


NOTES


© SK Design consultants - THIS DRAWING AND DESIGN REMAINS THE COPYRIGHT AND INTELLECTUAL PROPERTY OF SK CONSULTANTS AND SHALL NOT BE COPIED IN ANY FORMAT WITHOUT APPROVAL.

THIS DRAWING IS TO BE READ IN CONJUNCTION WITH ALL OTHER DRAWINGS AND DOCUMENTS PROVIDED. THE CONTRACTOR MUST CHECK ALL DIMENSIONS ON SITE BEFORE PLACING ORDERS FOR MATERIALS OR SHOP FABRICATIONS OR COMMENCING WORKS ON SITE. ANY DISCREPANCIES SHOULD BE NOTIFIED BEFORE PROCEEDING.


V1 - Volume of gable = $W \times H \times L/6$
 $7.2 \times 2.8 \times 2.8/6 = 9.4 \text{ cm}^3$
V1 - Volume of gable = $W \times H \times L/6$
 $7.9 \times 3.1 \times 4.2/6 = 17.9 \text{ cm}^3$
V2 - Volume of rear dormer = $W \times H \times L/2$
 $5.1 \times 2.6 \times 3.1/2 = 20.5 \text{ cm}^3$
Total Volume = $V1 + V2 + V3 = 9.4 + 17.9 + 20.5 = 47.5 \text{ cm}^3$

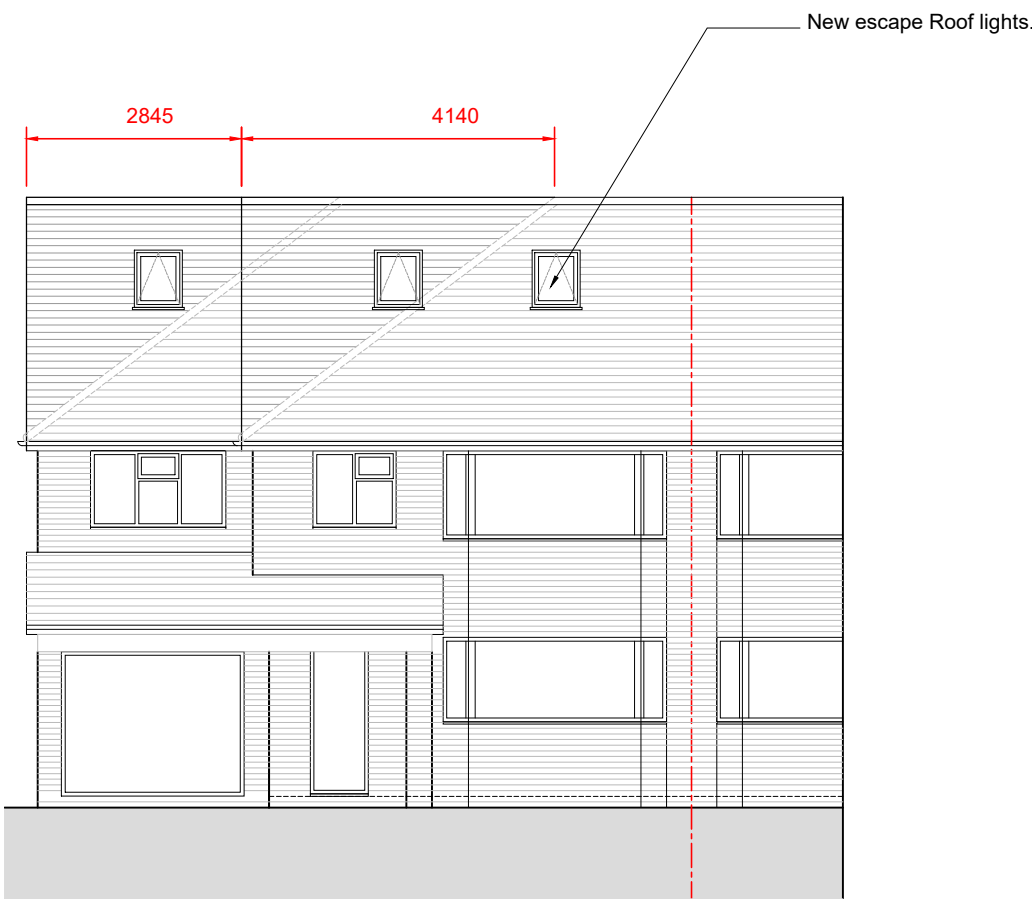

PROPOSED NORTH ELEVATION
SCALE 1 : 100

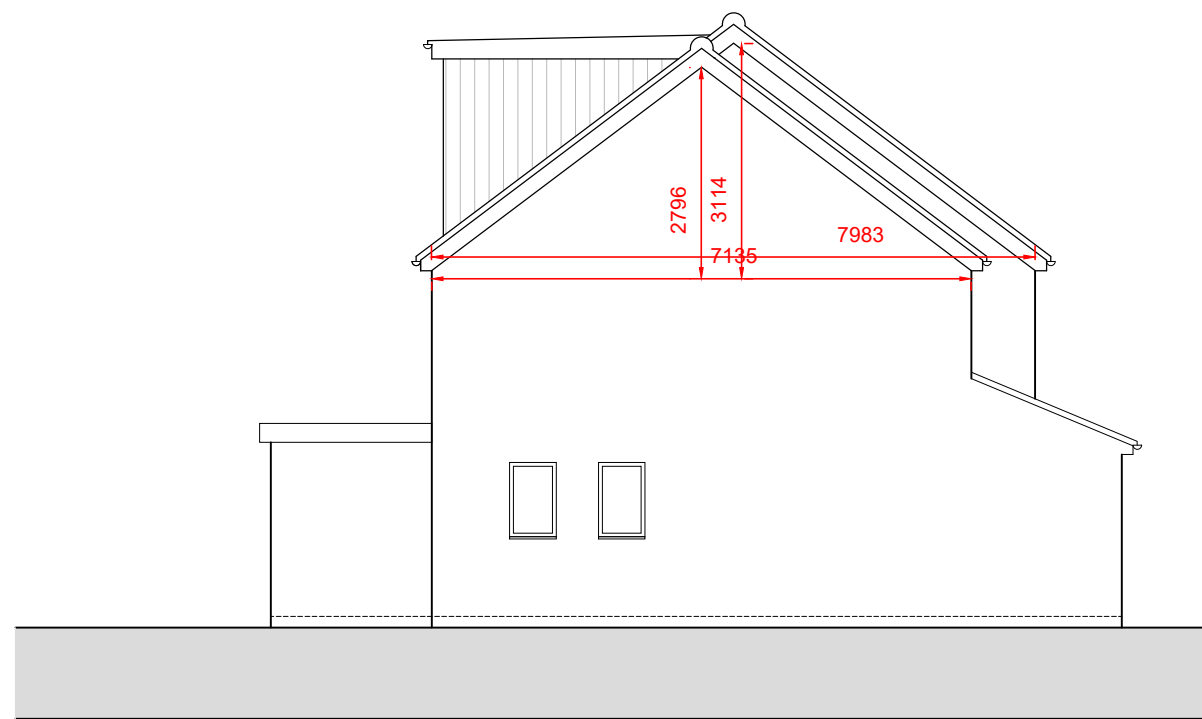

PROPOSED EAST ELEVATION
SCALE 1 : 100

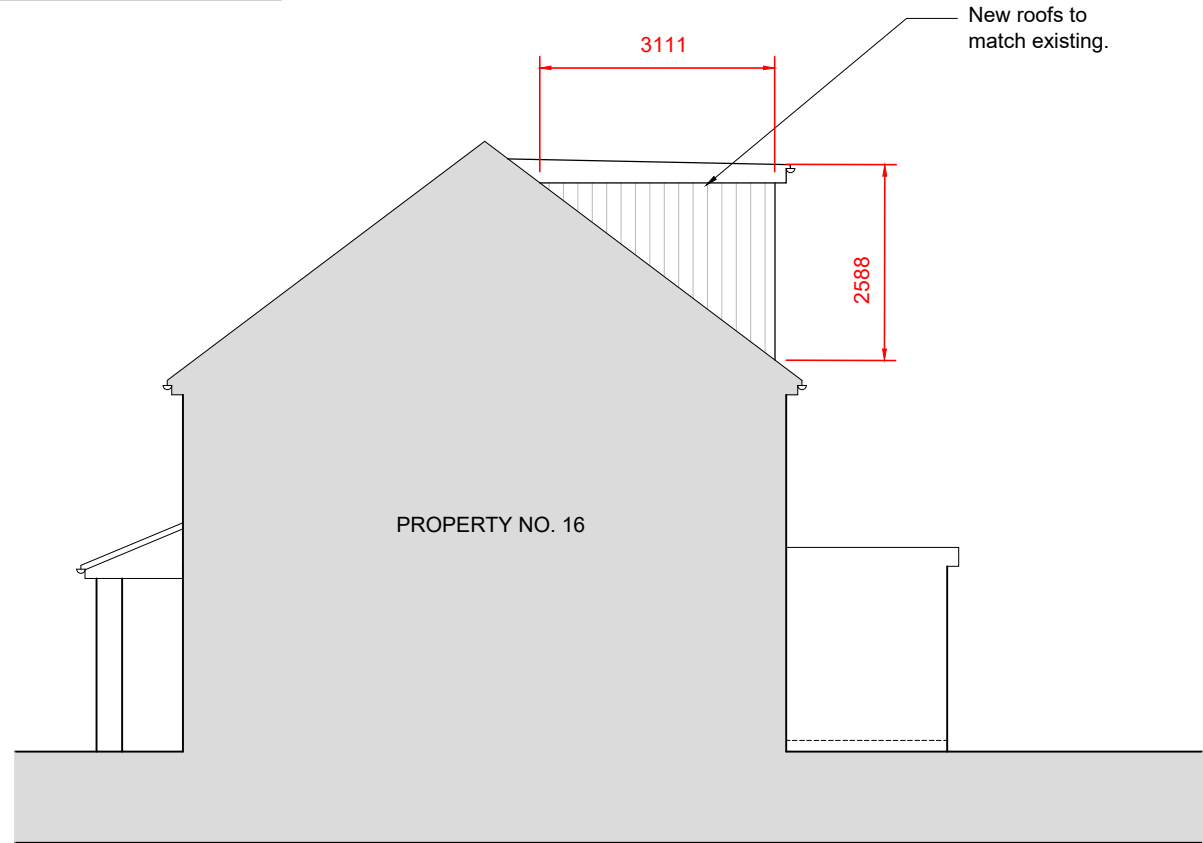


PROPOSED WEST ELEVATION
SCALE 1 : 100




PROPOSED SOUTH ELEVATION
SCALE 1 : 100



EXISTING NORTH ELEVATION
SCALE 1 : 100

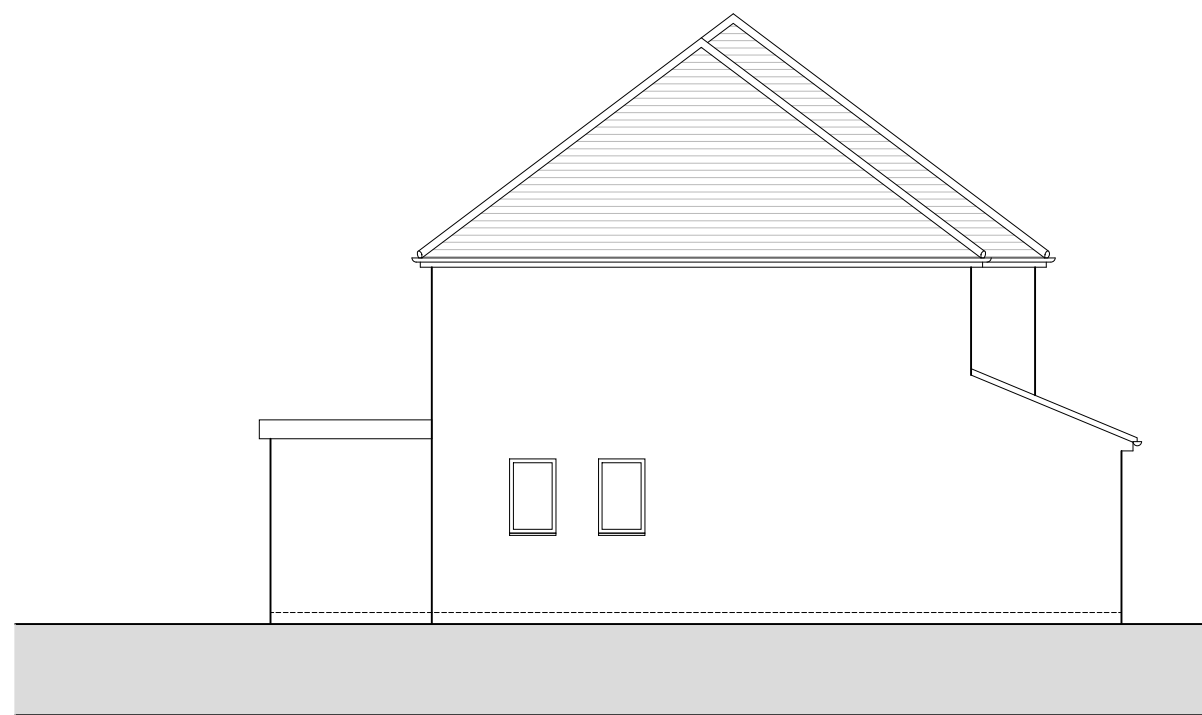


EXISTING EAST ELEVATION
SCALE 1 : 100

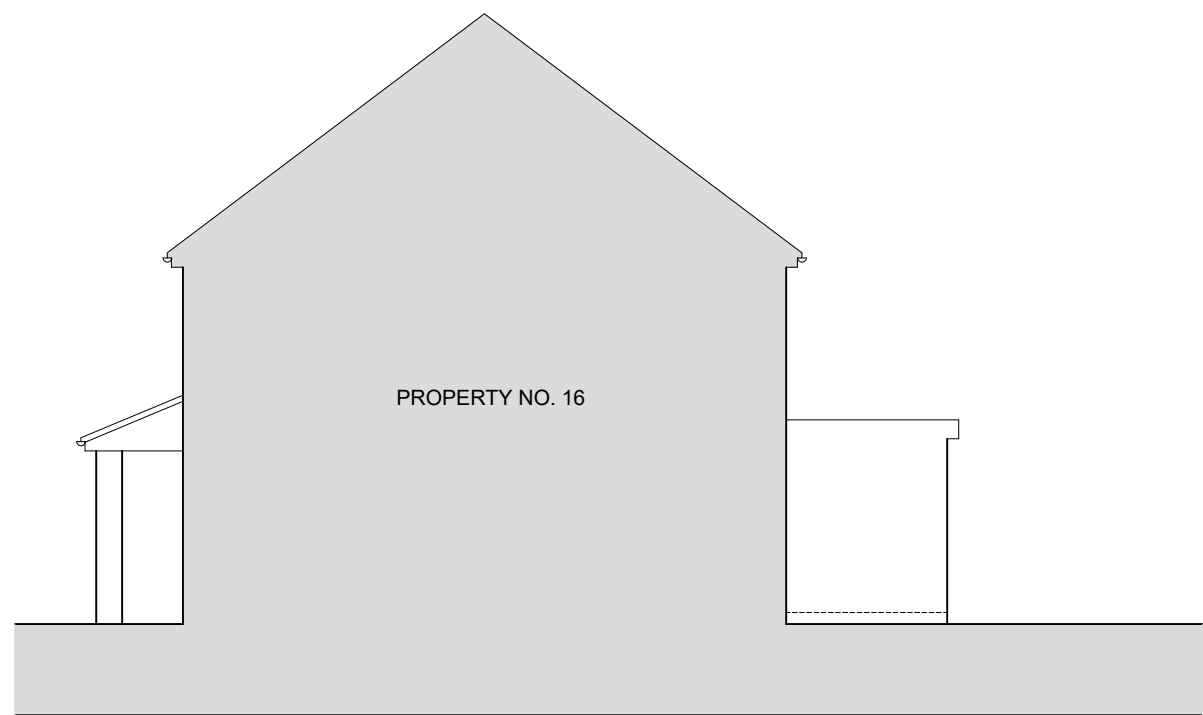


EXISTING WEST ELEVATION
SCALE 1 : 100




EXISTING SOUTH ELEVATION
SCALE 1 : 100

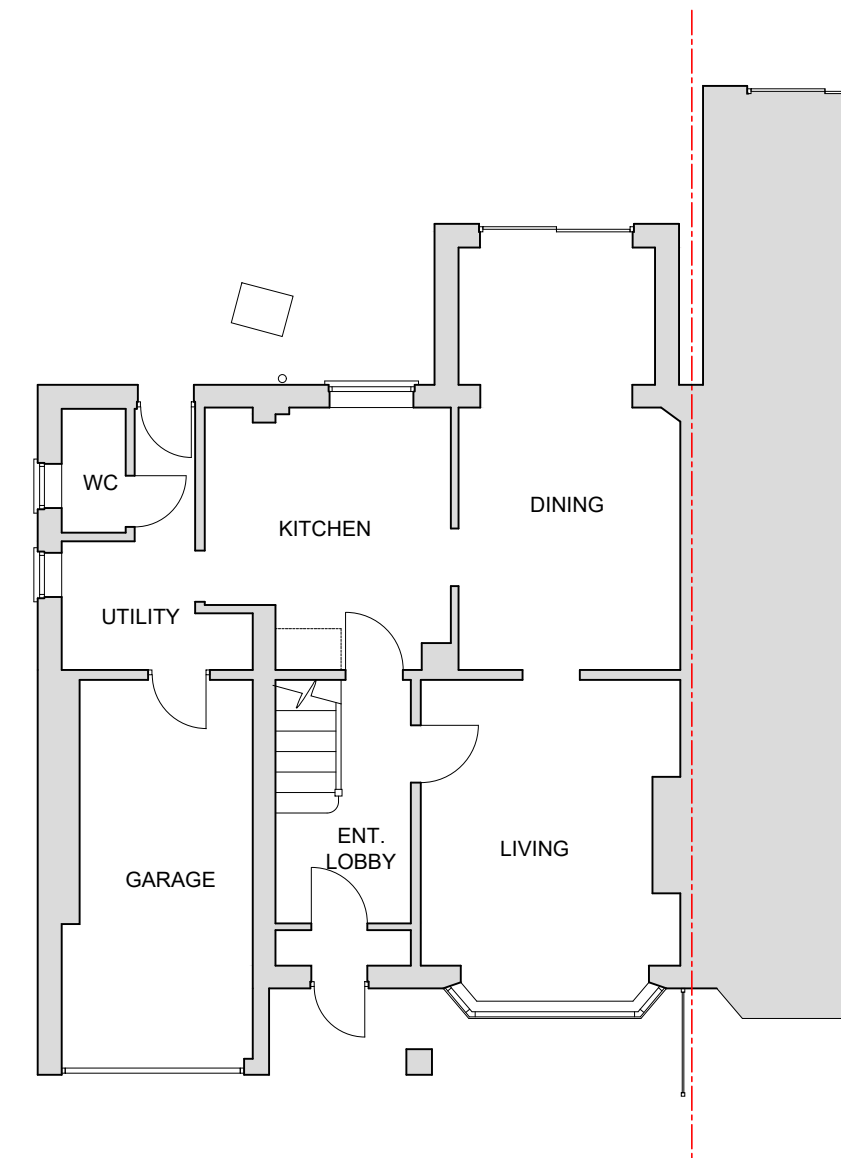


EXISTING GROUND FLOOR PLAN
SCALE 1 : 100

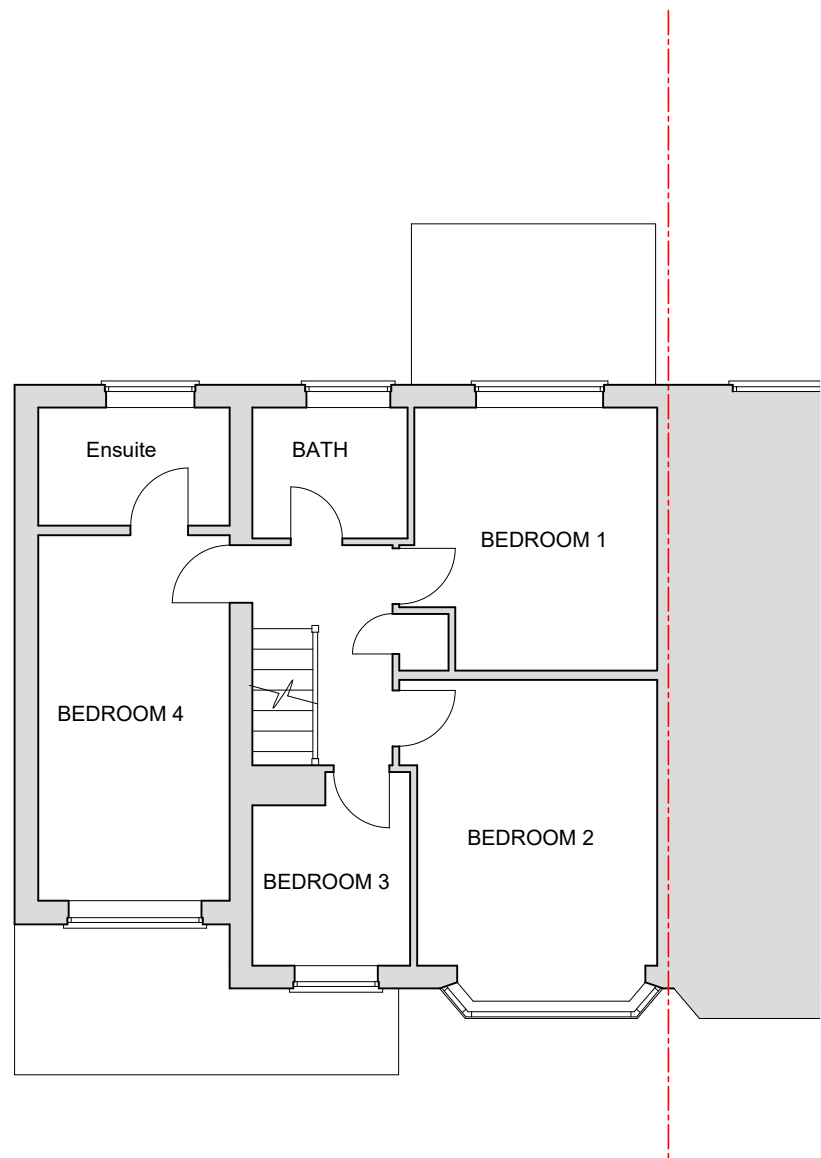


EXISTING FIRST FLOOR PLAN
SCALE 1 : 100

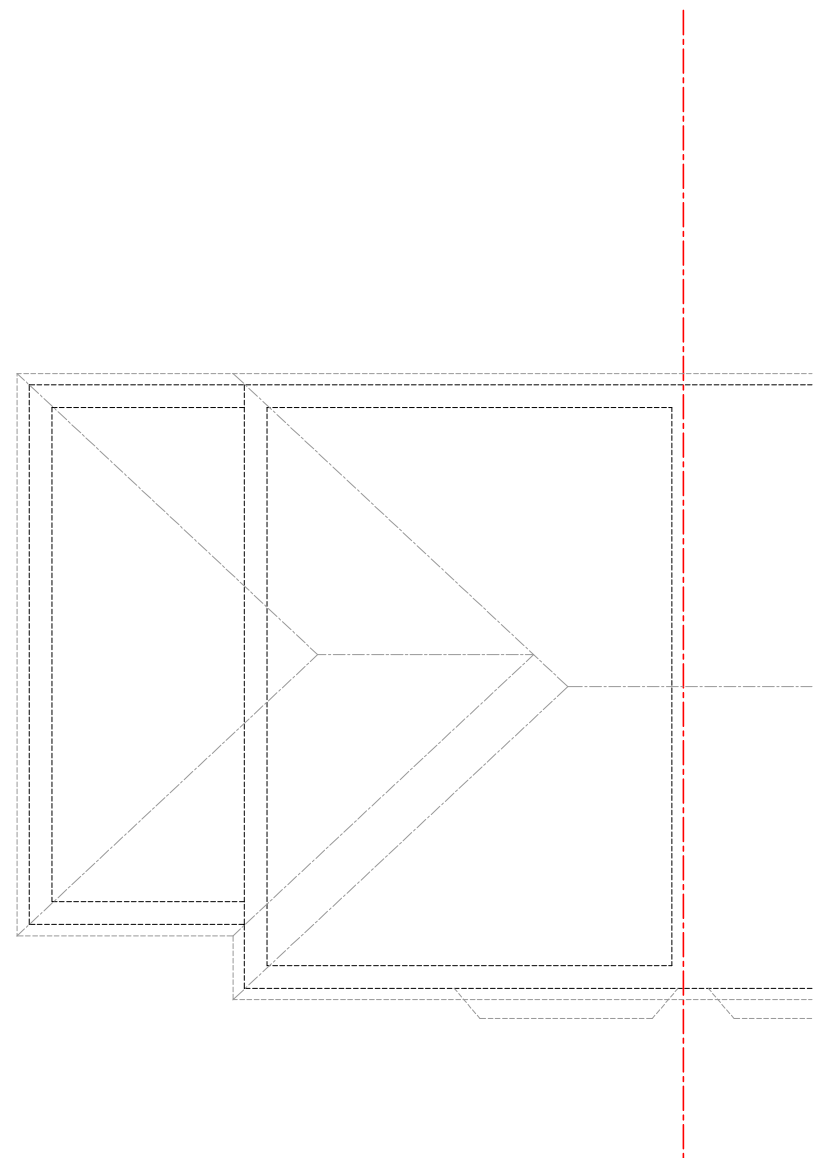


EXISTING LOFT PLAN
SCALE 1 : 100

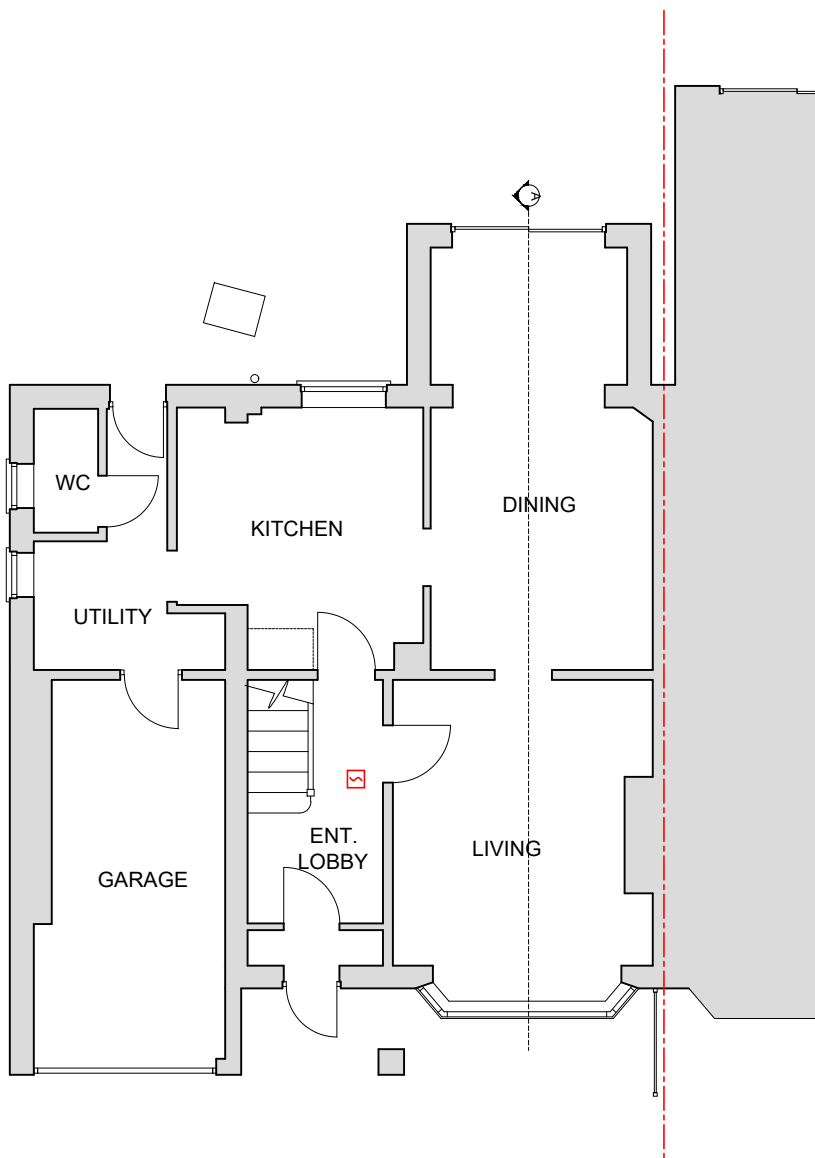

PROPOSED GROUND FLOOR PLAN
SCALE 1 : 100

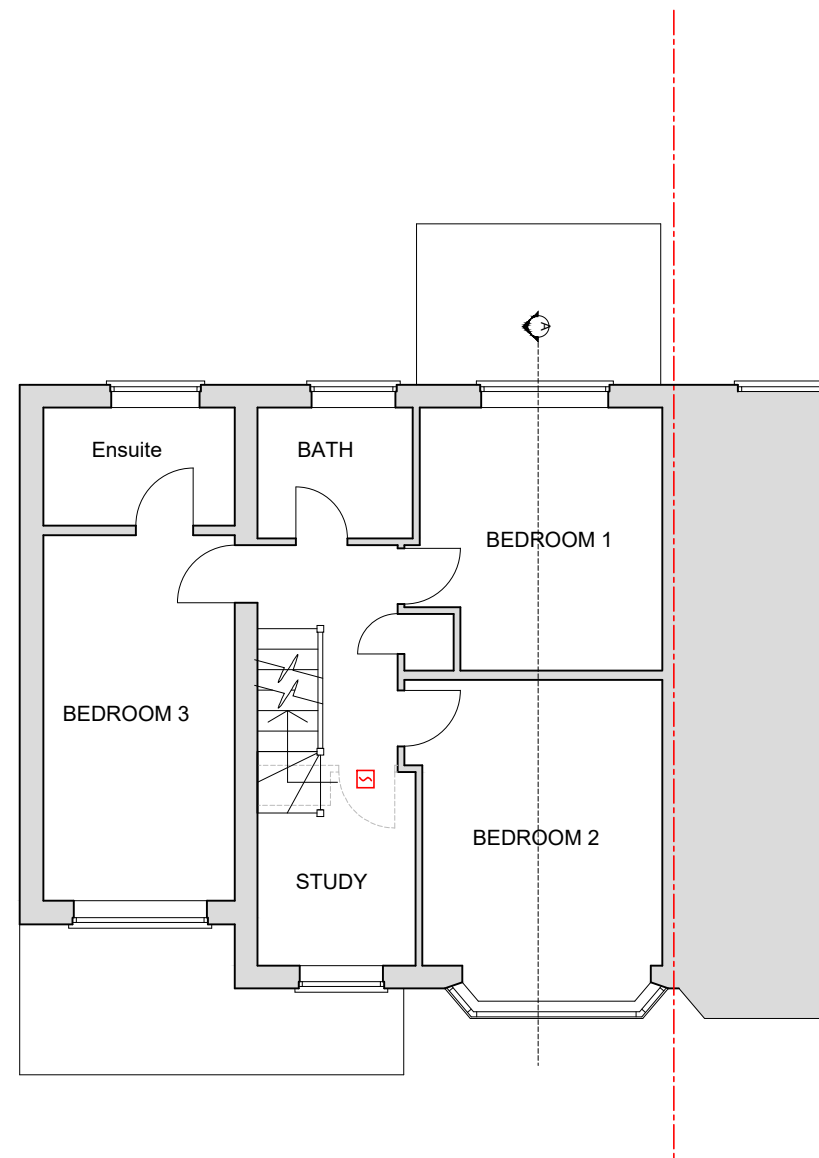

PROPOSED FIRST FLOOR PLAN
SCALE 1 : 100

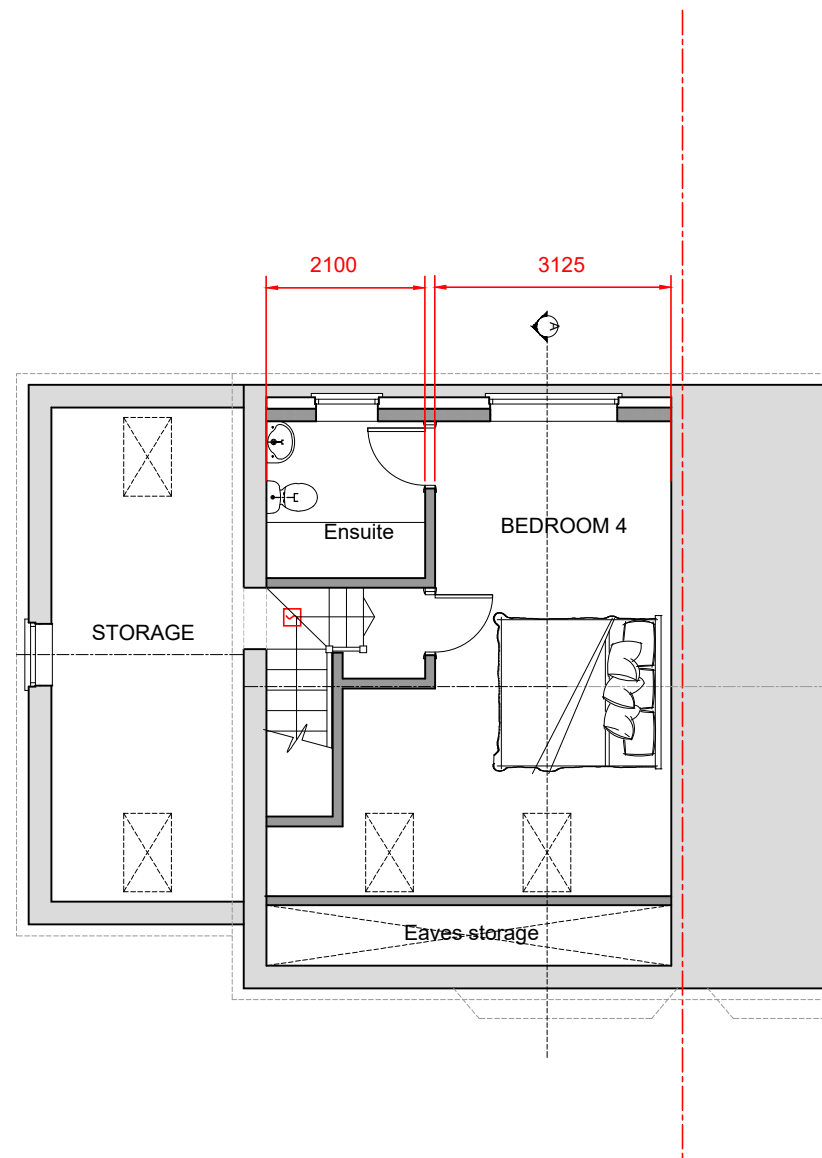

PROPOSED LOFT PLAN
SCALE 1 : 100



SK Design Consultants
22 Netley close
Caversham
Reading RG4 6SR
Tel : 07821111602

Client:
Mr KARAMJEET SINGH

Project:
LOFT CONVERSION

Location:
18 Selsdon Avenue , Woodley, Reading, RG5 4PG

Drawing Title:
PLANS AND ELEVATIONS

Date:
JAN 2026

Sheet Size:
A1

Drawn:
SK

Drawing No:
P1699 -03

Revision:
.